
NEW ADDITION / RENOVATION FOR: MR. & MRS. HILDEBRANDT 371 OAKWOOD DRIVE WYCKOFF, NJ

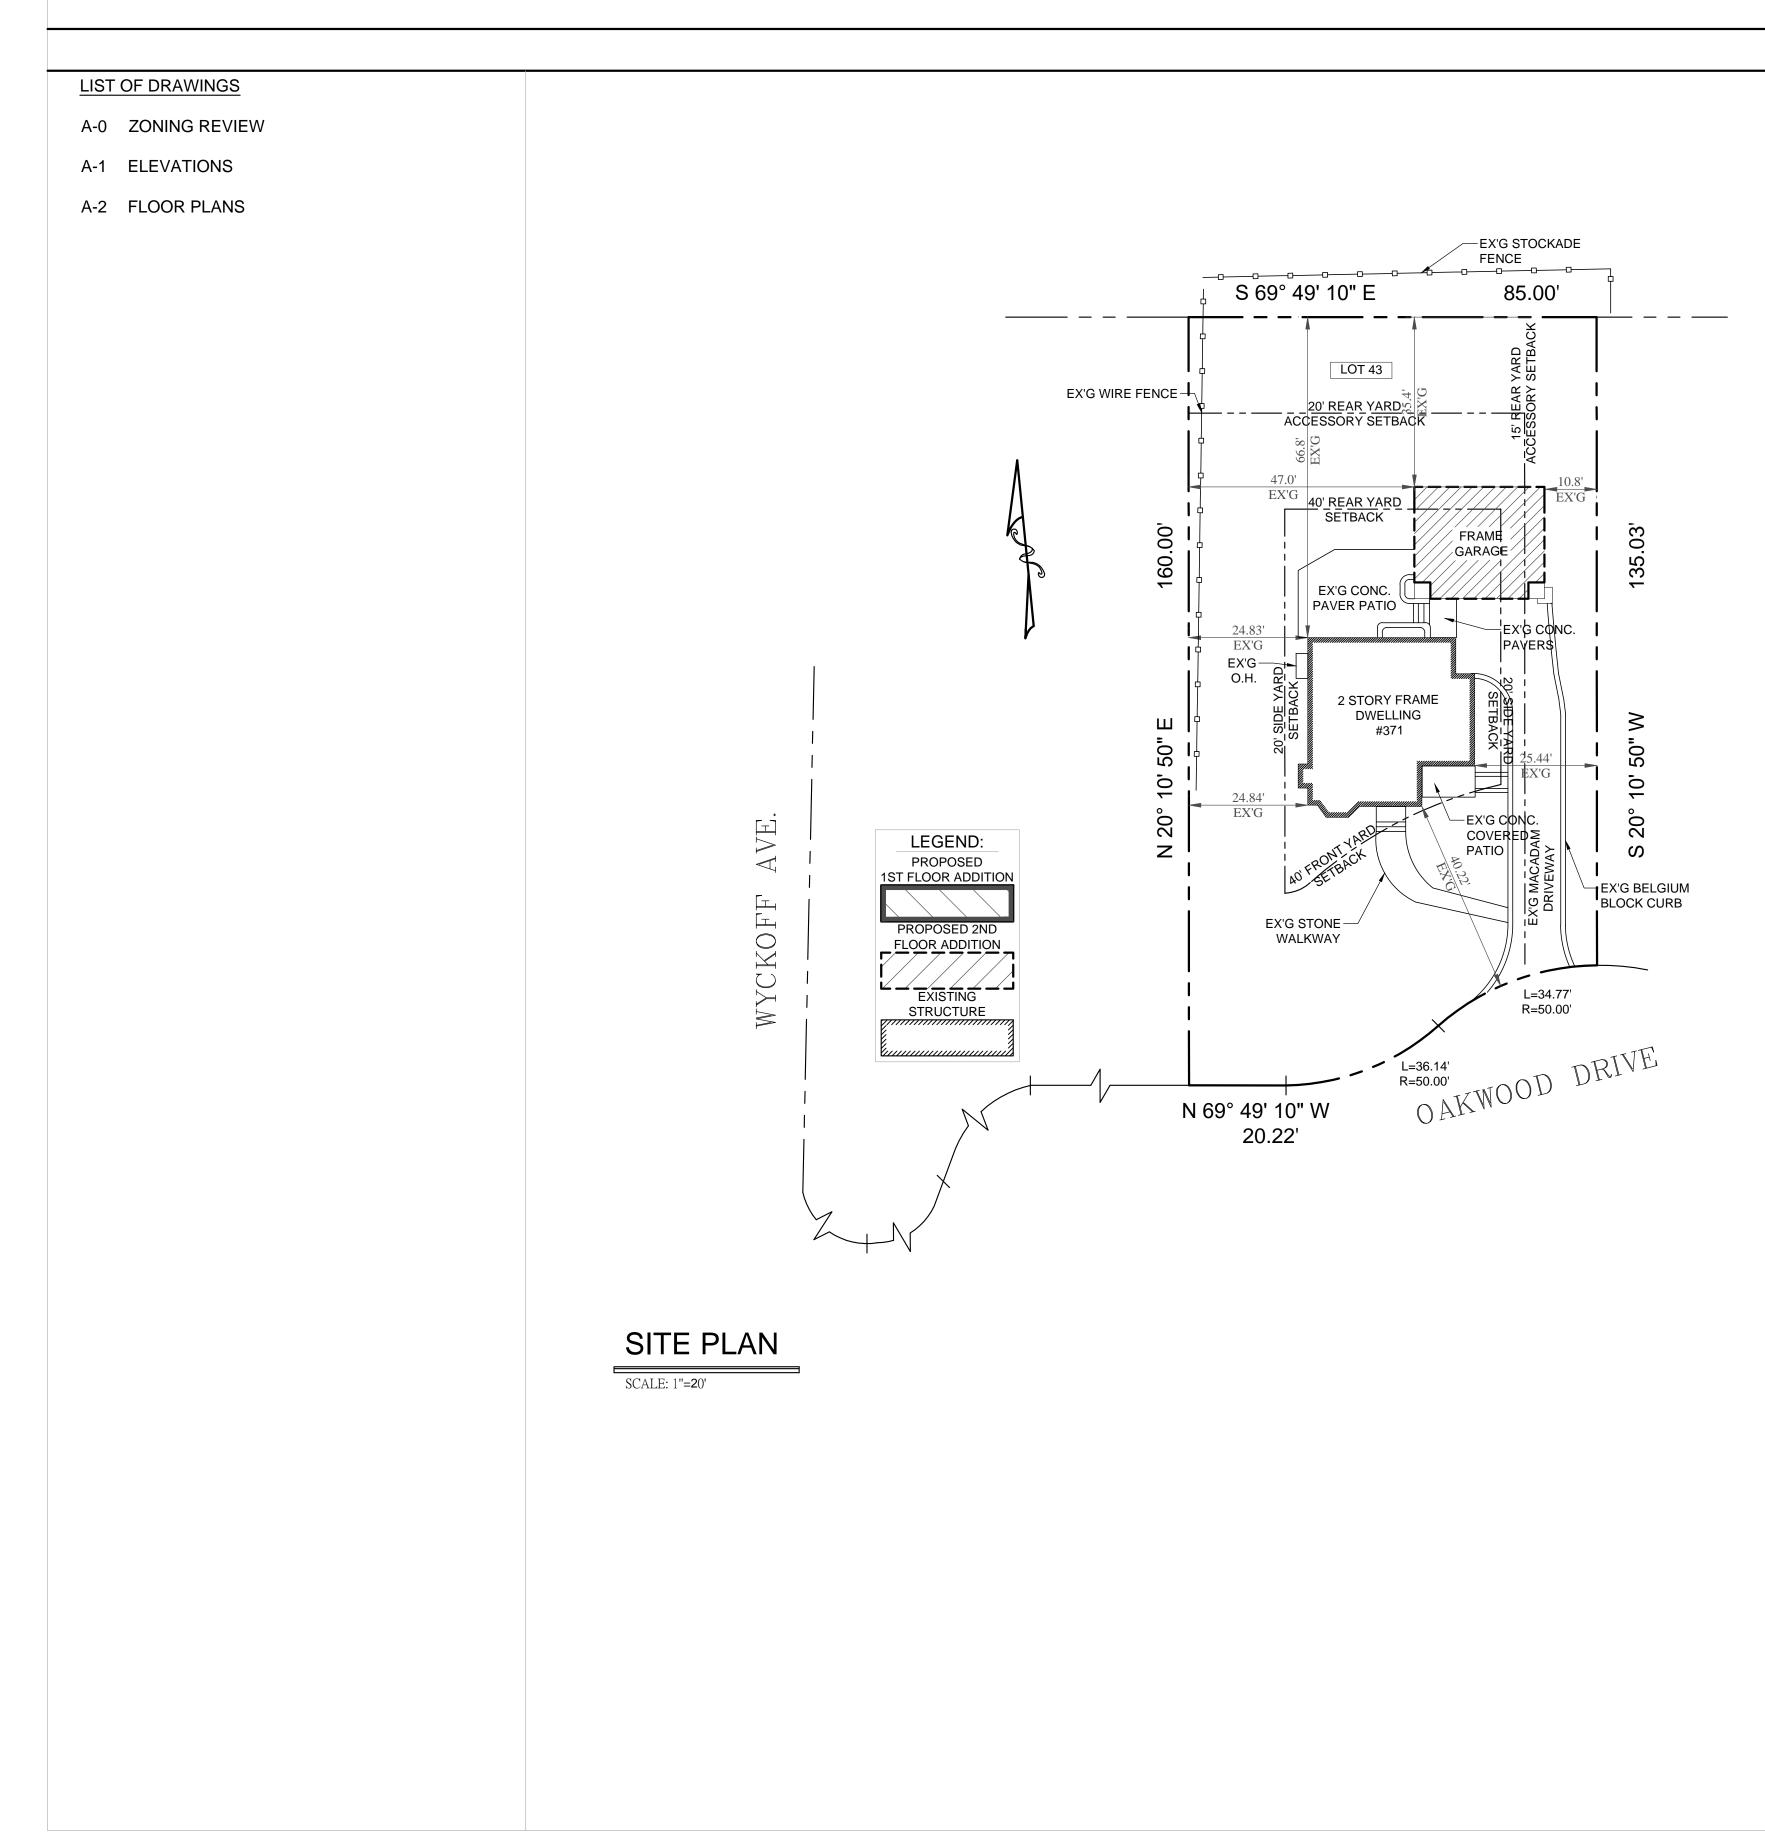

ZONING NOTE:		Ī	OWNSHIP OF V	VYCKOFF		
effect on existing zoning.	under this application has no Work is limited to second floor otprint of the detached garage.	TAX MAP LOT:43TAX BLOCK:250ZONE:RA-25 - RURAL RESIDUSE:SINGLE FAMILY DWEI				
PRINCIPAL BUI	LDING COVERAGE	ZONING REQUIREMENTS	REQUIRED	EXISTING	PROPOSED	VARIANCE
<u>STRUCTURE</u>	AREA	MINIMUM LOT REQUIREMENTS - MINIMUM LOT AREA - MINIMUM LOT FRONTAGE - MINIMUM LOT DEPTH	25,000 sq ft 125 ft 150 ft	12,807 sq ft 85 ft 148 ft	NO CHANGE NO CHANGE NO CHANGE	NONE NONE NONE
EX'G PRINCIPAL BUILDING COVERA ACCESSORY BU EX'G ACCESSORY BUILDING COVERAGE	AGE 1,125 SQFT	PRINCIPAL BUILDING - RIGHT SIDE YARD SETBACK - LEFT SIDE YARD SETBACK - FRONT YARD SETBACK - REAR YARD SETBACK	20 ft 20 ft 40 ft 40 ft	25.44 ft 24.83 ft 40.22 ft 66.80 ft	NO CHANGE NO CHANGE NO CHANGE NO CHANGE	NONE NONE NONE NONE
STRUCTURE	AREA 1,755 SQFT	ACCESSORY BUILDING - REAR SETBACK - MIN. LEFT SIDE SETBACK - MIN. RIGHT SIDE SETBACK MAXIMUM BUILDING HEIGHT	20 ft 15 ft 15 ft 20 ft	35.4 ft 40 ft 10.8 ft 15.8 ft	NO CHANGE NO CHANGE NO CHANGE 21.7 ft	NONE NONE ENC YES
EX'G DRIVEWAY EX'G WALKWAYS EX'G PAVED PATIO TOTAL EX'G COVERAGE	+ 1,118 SQFT + 154 SQFT + 574 SQFT = 3,601 SQFT = 28.11%	MAXIMUM LOT COVERAGE - PRINCIPAL BUILDING COV. - ACCESSORY BUILDING - COMBINED BUILDING - IMPER. / TOTAL COVERAGE - GROSS BUILDING AREA	15% 5% 20% 28.5% MAX. x>3,700 sqft	8.78 % 4.92 % 13.70 % 28.11 % N/A	NO CHANGE NO CHANGE NO CHANGE NO CHANGE N/A	NONE NONE NONE NONE NONE
		MAXIMUM BUILDING HEIGHT MAXIMUM NO. OF STORIES	35' 2-½	N/A N/A	N/A N/A	NONE NONE

ZONING NOTE:		<u> </u>	OWNSHIP OF V	VYCKOFF		
effect on existing zoning.	ed under this application has no Work is limited to second floor ootprint of the detached garage.	TAX MAP LOT:43TAX BLOCK:250ZONE:RA-25 - RURAL RESIDUSE:SINGLE FAMILY DWEI				
	ILDING COVERAGE	ZONING REQUIREMENTS	REQUIRED	EXISTING	PROPOSED	VARIANCE
STRUCTURE	AREA EXISTING	MINIMUM LOT REQUIREMENTS - MINIMUM LOT AREA - MINIMUM LOT FRONTAGE - MINIMUM LOT DEPTH	25,000 sq ft 125 ft 150 ft	12,807 sq ft 85 ft 148 ft	NO CHANGE NO CHANGE NO CHANGE	NONE NONE NONE
ACCESSORY BUILDING COVE	I,125 SQFT UILDING COVERAGE 630 SQFT	PRINCIPAL BUILDING - RIGHT SIDE YARD SETBACK - LEFT SIDE YARD SETBACK - FRONT YARD SETBACK - REAR YARD SETBACK	20 ft 20 ft 40 ft 40 ft	25.44 ft 24.83 ft 40.22 ft 66.80 ft	NO CHANGE NO CHANGE NO CHANGE NO CHANGE	NONE NONE NONE NONE
STRUCTURE	US COVERAGE AREA EXISTING 1,755 SQFT	ACCESSORY BUILDING - REAR SETBACK - MIN. LEFT SIDE SETBACK - MIN. RIGHT SIDE SETBACK MAXIMUM BUILDING HEIGHT	20 ft 15 ft 15 ft 20 ft	35.4 ft 40 ft 10.8 ft 15.8 ft	NO CHANGE NO CHANGE NO CHANGE 21.7 ft	NONE NONE ENC YES
EX'G DRIVEWAY EX'G WALKWAYS EX'G PAVED PATIO FOTAL EX'G COVERAGE	+ 1,118 SQFT + 154 SQFT + 574 SQFT = 3,601 SQFT = 28.11%	MAXIMUM LOT COVERAGE - PRINCIPAL BUILDING COV. - ACCESSORY BUILDING - COMBINED BUILDING - IMPER. / TOTAL COVERAGE - GROSS BUILDING AREA	15% 5% 20% 28.5% MAX. x>3,700 sqft	8.78 % 4.92 % 13.70 % 28.11 % N/A	NO CHANGE NO CHANGE NO CHANGE NO CHANGE N/A	NONE NONE NONE NONE NONE
		MAXIMUM BUILDING HEIGHT MAXIMUM NO. OF STORIES	35' 2-½	N/A N/A	N/A N/A	NONE NONE

SITE PLAN DRAWN FROM SURVEY TAKEN BY: GUNTIS BOLE, NJ P.E. & L.S (LIC. 13,926) G.B ASSOCIATES, INC. DATED: DEC. 1. 1999 SITE PLAN TO BE USED FOR ZONING AND ARCHITECTURAL PURPOSES ONLY.

William G. Bro ARCHIT PLAN 241 Madis Wyck 07 PH: 201-8 FAX: 201 WEBSITE: Willia EMAIL: bill@will

ENC= EXISITNG NONCONFORMING EX'G= EXISTING NO CHANGE

*IF GROSS BUILDING AREA IS OVER 3,700 SQFT, THE SIDE YARD INCREASES TO 25 FT MIN & GARAGE FACE SIDE YARD BECOMES 27 FT MIN. THE GROSS BUILDING AREA

FLOOR AREA, GROSS

The sum of the gross horizontal areas of a floor or several floors of a building, including enclosed building projections, porches or similar enclosed structures, and including areas used for human occupancy in basements, all as measured from the exterior building dimensions. It shall not include unoccupied floors in any basement, cellar, open porches or balconies, garage space or accessory building. [amended 6-13-1989 by ord. no. 1069]


IMPERVIOUS COVERAGE

Land surface areas that do not allow rainwater to be directly absorbed by the ground. These surfaces shall include but not be limited to building coverage, driveways (paved, gravel, cinder or pavers), paved areas, and decks which do not allow free drainage of rainwater through to the ground underneath. Impervious coverage in residential zones shall not include retaining walls, surface areas of swimming pools and their surrounding patios or hardscape Features, air-conditioning units, generators, pool equipment, walkways and at-grade patios located in the rear yard of the property, regardless of material types. Driveways, front and side yard walkways and patios, structures, and any type of sport athletic court shall be considered impervious coverage and shall remain as part of the impervious calculation. [added 2-19-2008 by ord. no. 1576; amended 8-2-2016 by ord. no. 1807]

PRINCIPAL BUILDING


A building or buildings in which is conducted the main or principal use of the lot on which said building is situated.

own, Architects	THESE DRAWINGS ARE NOT TO BE REPRODUCED IN ANY MANNER WITHOUT THE EXPRESS WRITTEN		COVER SHEET
N I N G son Avenue koff, NJ	AUTHORIZATION OF THE ARCHITECT WILLIAM G. BROWN.	INN	ADDITION / RENOVATION FOR: MR. AND MRS. HILDEBRANDT
7481 -891-3285	CT ARCH 8445 NY ARCH 018837 NJ ARCH 10226		371 OAKWOOD DRIVE WYCKOFF, NJ
1-891-3695 liamGBrown.com	PA ARCH RA-011586-B VA ARCH RA-007125	WILLIAM G. BROWN, JR., AIA	PROJECT: 20-223 DATE: 08-24-20 DRAWN BY: LR
illiamgbrown.com		A-0 ZONING REVIEW	ISSUED FOR VARIANCE: SEPTEMBER 25, 2020

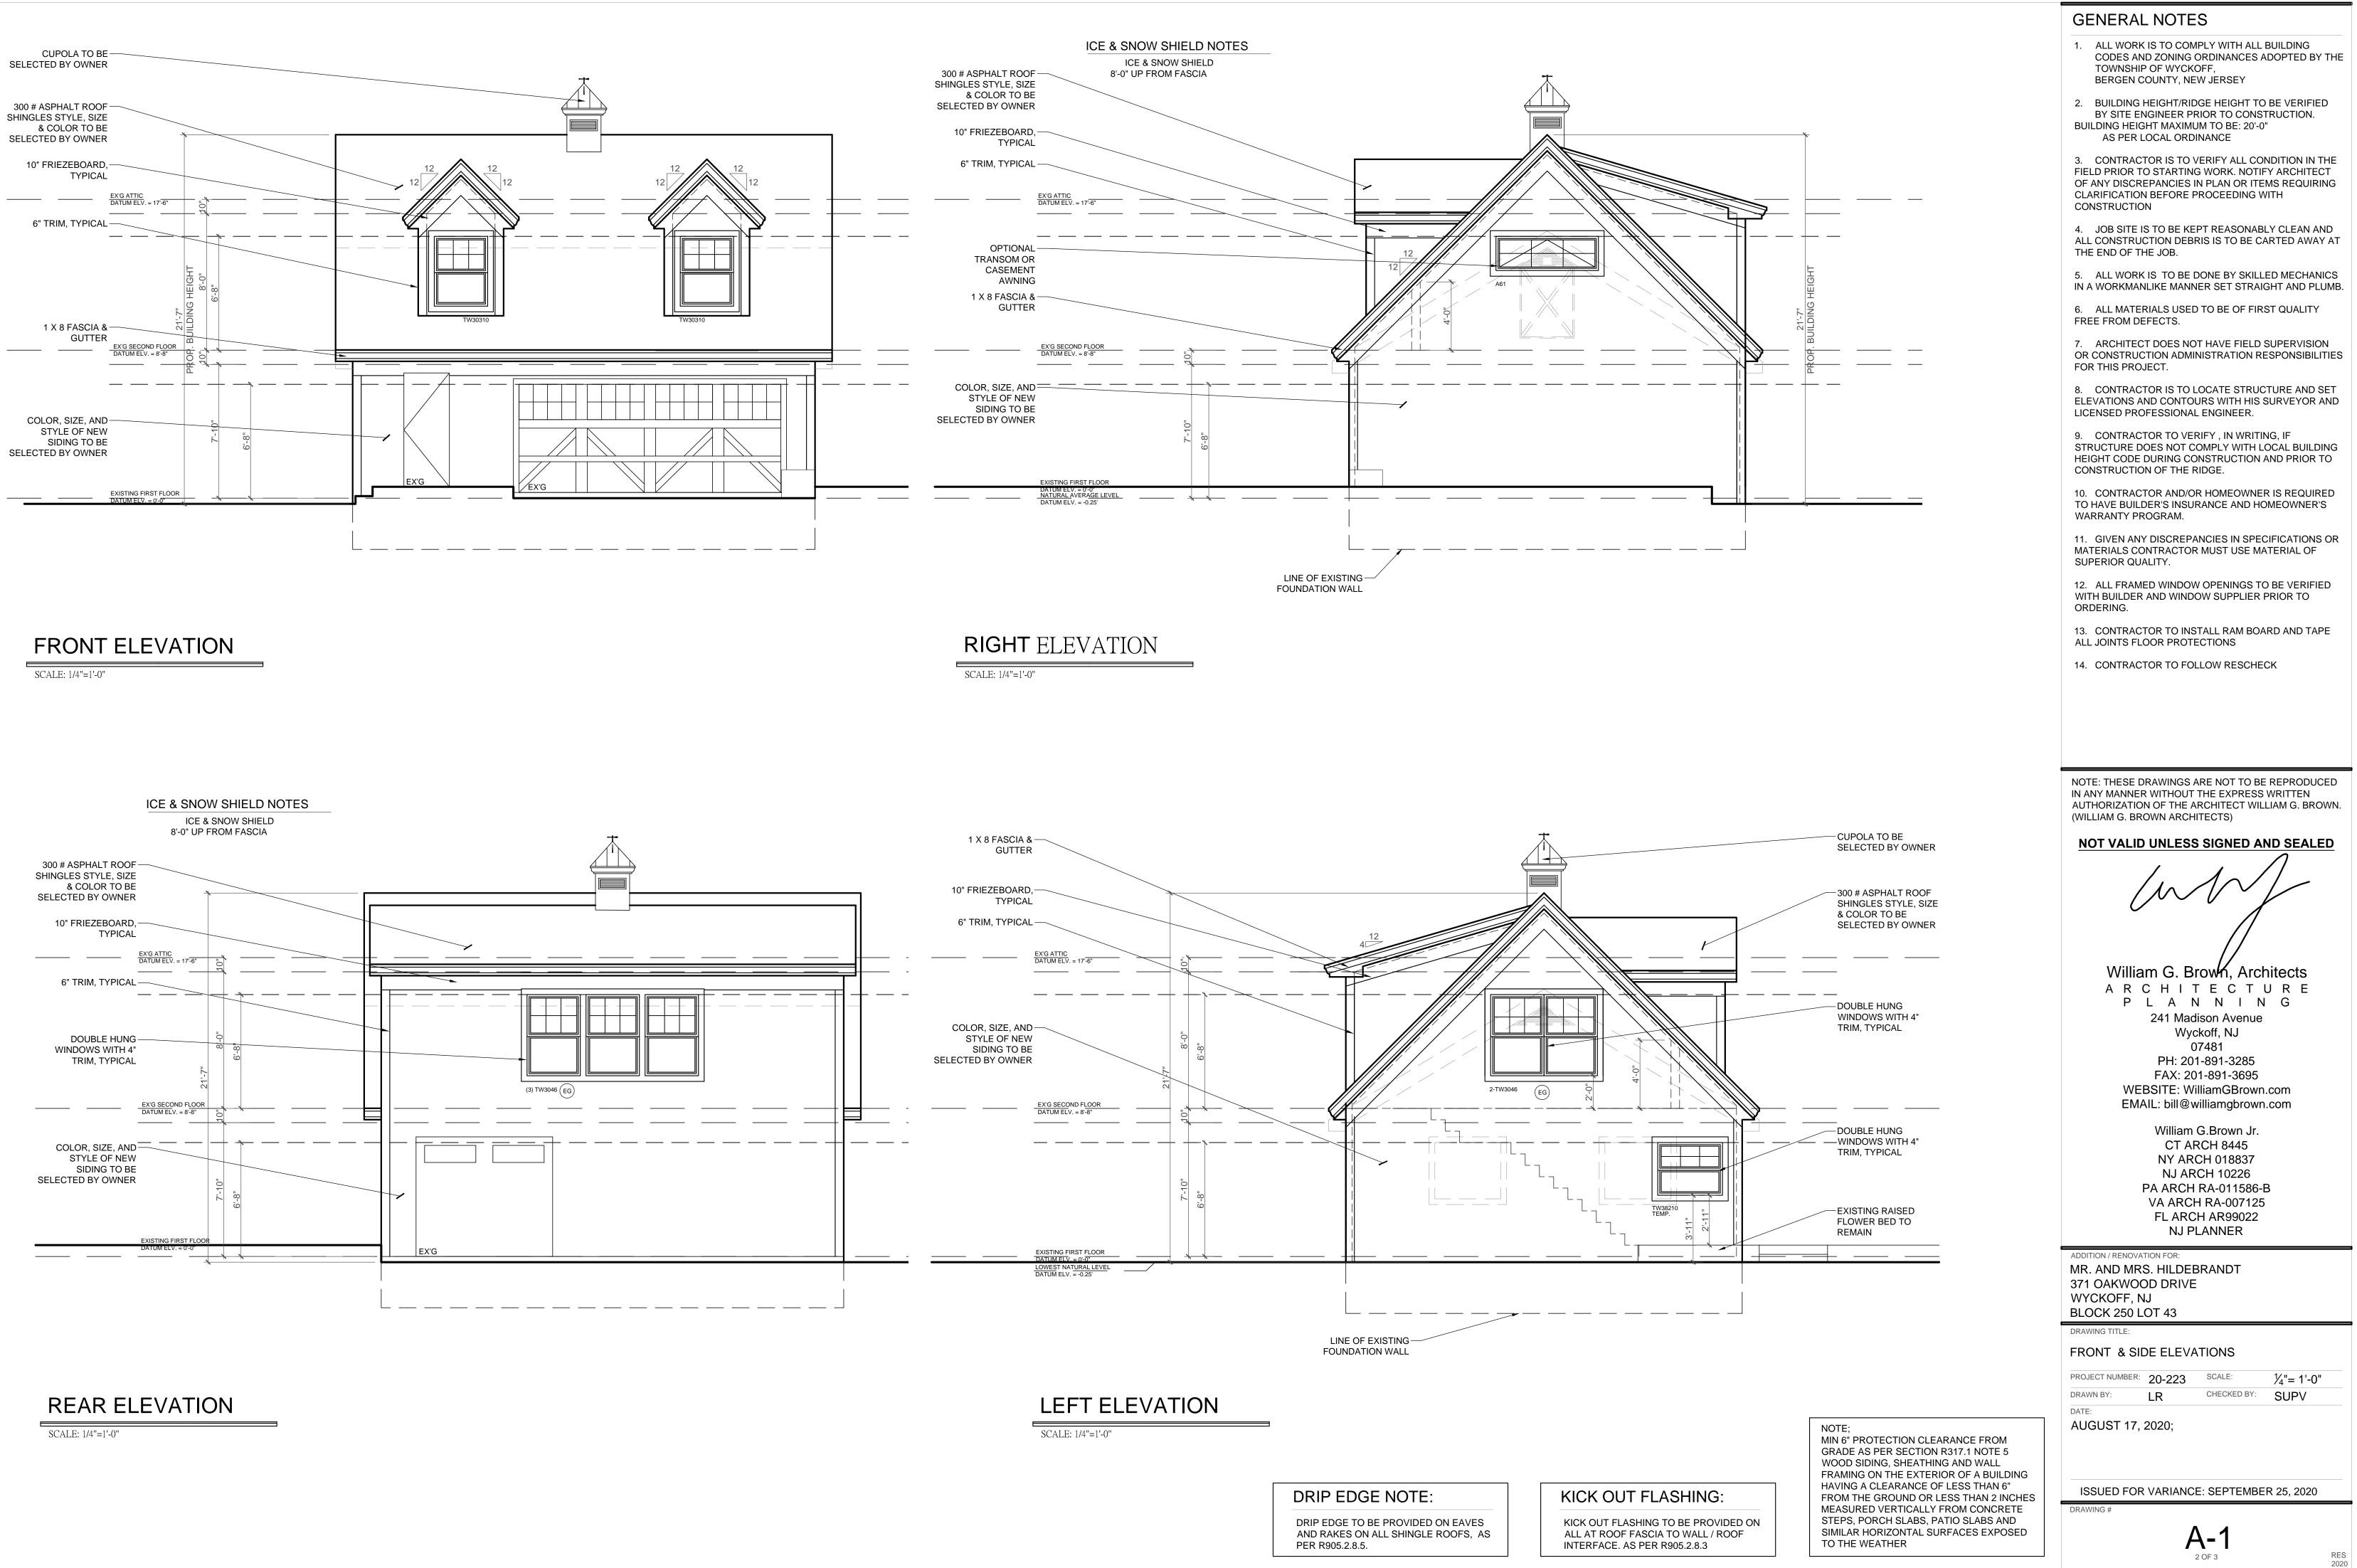


CARPENTRY NOTES

- 1. ALL FRAMING LUMBER IS TO BE DOUGLAS FIR WITH Fb-1500 PSI AND BE OF STRUCTURAL GRADE.
- 2. ALL DOOR AND WINDOW HEADERS TO BE 2-2"X12" UNLESS NOTED OTHERWISE.
- 3. ALL DOORS LABELED ARE TO BE 2'-8"X6'-8" SOLID 6 PANEL MASONITE. AS PER CODE, UNLESS OTHERWISE NOTED.
- 4. ALL DOORS LABELED (D-8) ARE TO BE 2'-8"X8'-0" SOLID CORE 2 PANEL OVATION AS PER CODE, UNLESS OTHERWISE NOTED (1 ³/₄", 4 HINGES)
- 5. PERIMETER WALLS FRAMING TO BE 2X6 AT 16" O.C WITH SINGLE CONTINUOUS SOLE PLATE AND DOUBLE CONTINUOUS TOP PLATE JOINTS TO BE STAGGERED.
- 6. INTERIOR PARTITION FRAMING TO BE 2X4 AT 16" O.C WITH SINGLE CONTINUOUS SOLE PLATE AND DOUBLE CONTINUOUS TOP PLATE JOINTS TO BE STAGGERED.
- 7. ALL WALLS OVER 8'-0" HIGH ARE TO RECEIVE FIRE BLOCKING AT MIDPOINT.
- 8. SILLS ON BLOCK WALLS TO BE WOLMANIZED.
- 9. WINDOWS AND SLIDING DOORS GLASS DOORS TO BE DONE BY: TOWER WINDOWS 1-800-490-1011
- 10. ALL EXTERIOR WALLS, ROOF OR CEILING TO HAVE FULL=THICK BATT INSULATION.
- 11. WALLS TO BE 6" WHERE ANY 2" OR LARGER HORIZONTAL HOLE IS DRILLED .
- 12. TJI HOLE TO BE DRILLED FOLLOWING MANUFACTURES CALCULATIONS TJI'S CAN'T BE NOTCHED.
- 13. CONTRACTOR'S MAY USE TJI'S AS AN ALTERNATE, W/ EQUAL OR GREATER STRENGTH MUST NOTIFY ARCHITECT.
- 14. ALL WOOD FRAMING MEMBERS, INCLUDING SHEATHING, WHICH REST ON EXTERIOR FOUNDATION WALLS AND ARE LESS THAN 8" FROM EXPOSED EARTH SHALL BE OF APPROVED NATURALLY DURABLE AND PRESERVATIVE-TREATED WOOD, INCLUDING LUMBER ON CONCRETE
- 15. FIRE BLOCKING SHALL BE PROVIDED AT WALL/CEILING INTERSECTION FOR BOTH INTERIOR PARTITIONS AND PERIMETER WALL; ALSO HORIZONTALLY EVERY TEN FEET.
- 16. INSULATOR TO INSTALL STYROFOAM BAFFLES WHERE NEEDED FOR VENTING

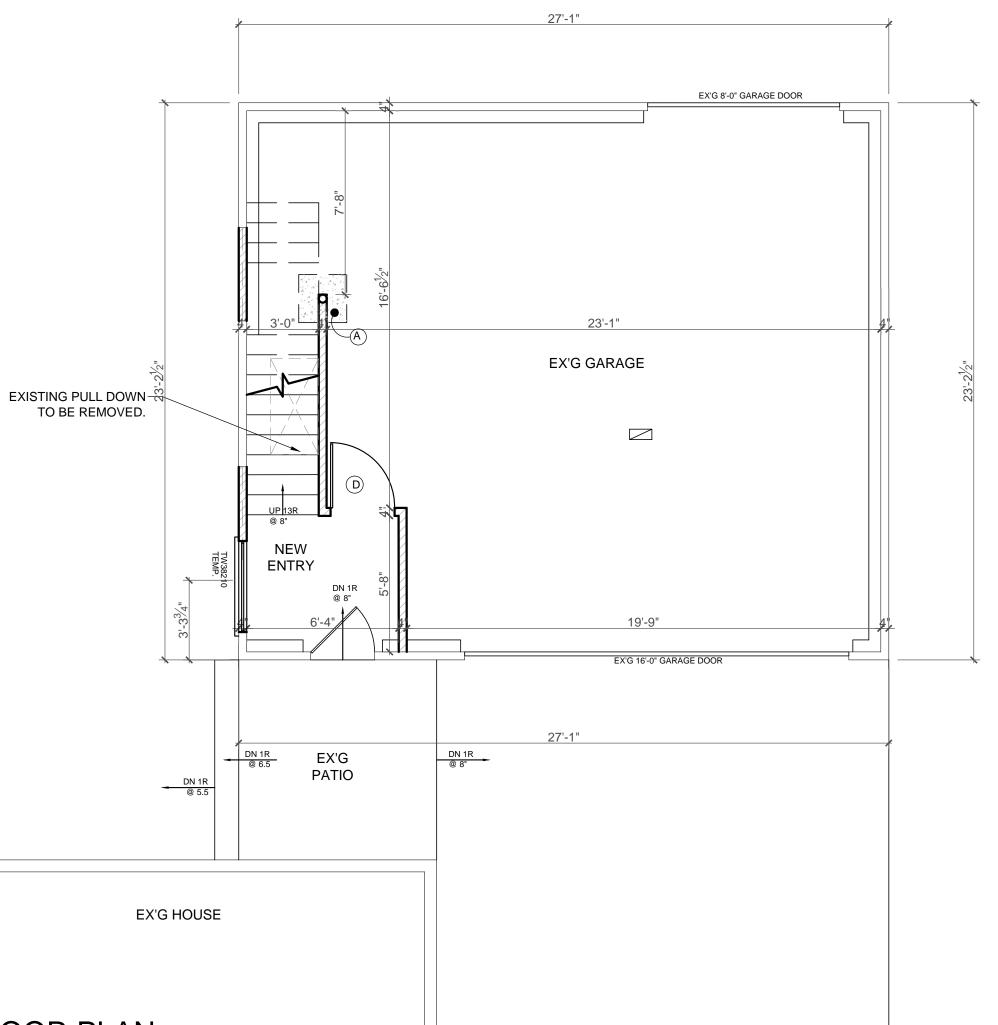

FIRST FLOOR PLAN

SCALE: 1/4"=1'-0"

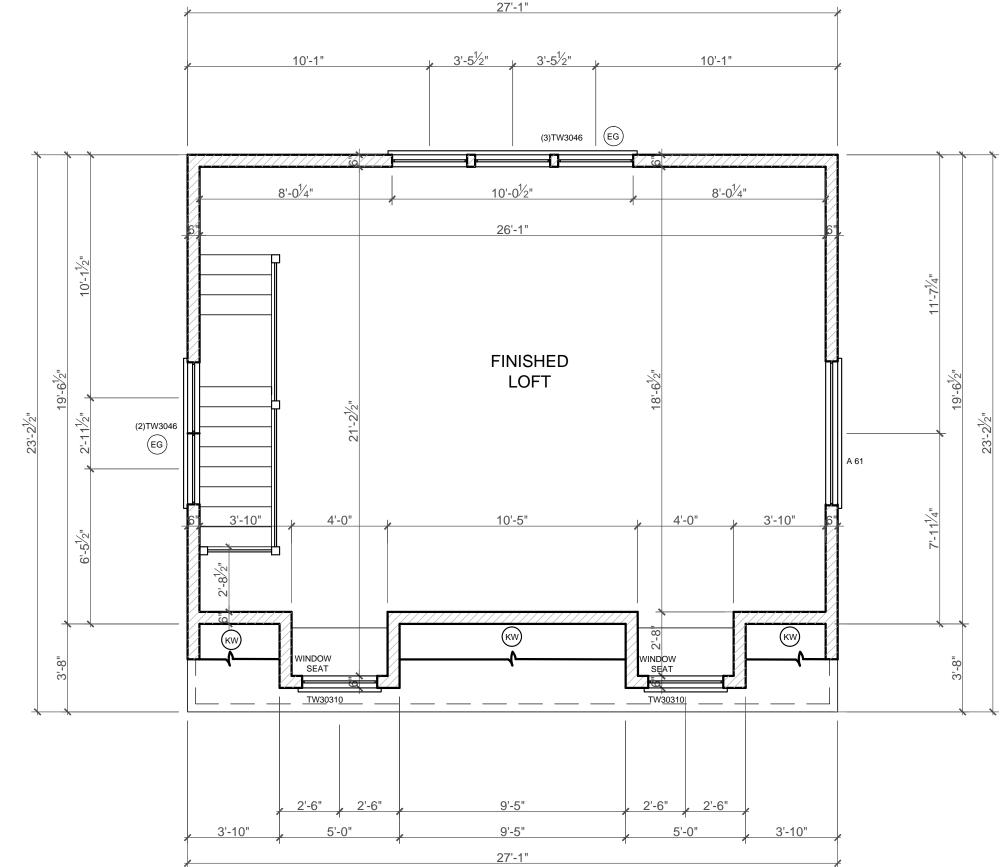

SECOND FLOOR PLAN

SCALE: 1/4"=1'-0"



1. ENERGY EFFICIENT LIGHTING: SEE www. njenergystarhomes.com

INSULATION CHECKLIST

- 2. MECHANICAL VENTILATION SYSTEM: HVAC NTEGRATED WHOLE-HOUSE VENTILATION SYSTEM
- 3. HIGH EFFICIENCY CENTRAL HEATING AND COOLING SYSTEMS: CENTRAL AIR CONDITIONING SYSTEMS AND HEAT PUMPS MUST BE PROPERLY SIZED PRE ACCA MANUAL J
- 4. AIR TIGHT DUCTWORK: BUILDING CAVITIES MAY NOT BE USED AS DUCTS; THE ENTIRE SYSTEMS MUST BE FULLY DUCTED
- 5. INSULATION VERIFIED: INSULATION IS INSPECTED PRIOR TO DRYWALL AND ASSESSED A GRADE LEVEL BASED ON INSULATION QUALITY
- 6. CONTRACTOR TO FOLLOW RESCHECK
- 7. CONTRACTOR TO COMPLY WITH IECC AND ENERGY SUBCODE, NJAC 5:23-3.18

WILLIAM G. BROWN, ARCHITECTS CALCULATES SQUARE FOOTAGE FROM THE INSIDE FRAME LINE DIMENSIONS, GARAGE SQUARE FOOTAGE LINE DIMENSIONS. GARAGE SQUARE FOOTAGE IS NOT INCLUDED IN THE TOTAL LIVEABLE SQUARE FOOTAGE. IN ADDITION, STAIRWELLS AND FIREPLACE MASSES ARE ONLY INCLUDED ONCE WITH THE MAIN LEVEL FIGURES

BUILDING DATA USE GROUP CONSTRUCTION CLASS	R5 VB	
<u>BUILDING AREA</u> EX'G BUILDING FOOTPRINT NEW BUILDING FOOTPRINT TOTAL BUILDING FOOTPRINT	630 0 630	SQFT SQFT SQFT
EX'G GARAGE	595	SQFT
MODIFIED GARAGE	553	SQFT
NEW ENTRY	36	SQFT
EX'G LOFT	0	SQFT
NEW LOFT	468	SQFT
EX'G LIVABLE SFTG.	0	SQFT
NEW LIVABLE SFTG.	504	SQFT
TOTAL LIVABLE SFTG.	504	SQFT
CONTAINED VOLUME	5,109	CUFT

NOTE: THESE DRAWINGS ARE NOT TO BE REPRODUCED IN ANY MANNER WITHOUT THE EXPRESS WRITTEN AUTHORIZATION OF THE ARCHITECT WILLIAM G. BROWN. (WILLIAM G. BROWN ARCHITECTS)

NOT VALID UNLESS SIGNED AND SEALED

William G. Brown, Architects

A R C H I T E C T U R E P L A N N I N G

241 Madison Avenue Wyckoff, NJ

07481 PH: 201-891-3285 FAX: 201-891-3695 WEBSITE: WilliamGBrown.com EMAIL: bill@williamgbrown.com
William G.Brown Jr. CT ARCH 8445 NY ARCH 018837 NJ ARCH 10226 PA ARCH RA-011586-B VA ARCH RA-007125 FL ARCH AR99022
ADDITION / RENOVATION FOR: MR. AND MRS. HILDEBRANDT 371 OAKWOOD DRIVE WYCKOFF, NJ BLOCK 250 LOT 43
DRAWING TITLE: FLOOR PLANS
PROJECT NUMBER: 20-223 SCALE: 1/4"= 1'-0"
DRAWN BY: LR CHECKED BY: SUPV DATE: AUGUST 17, 2020;
ISSUED FOR VARIANCE: SEPTEMBER 25, 2020
DRAWING #

A-2

3 OF 3

2		
10'-0 ¹ /2"	. 8'-0 ¹ /4"	
26'-1"	6	
FINISHED LOFT	18'-6/2"	11'-7/4" 19'-6/2" 23'-2/2"
10'-5"	A 61	7'-11//4"
ĸw		~~~~
9'-5"	2'-6"	
9'-5"	5'-0" 3'-10"	
27'-1"		

GENERAL FRAMING LEGEND :	
= EXISTING CONSTRUCTION TO REMAIN	

=	WALLS ABOVE
=	NEW CONSTRUCTION
=	NEW C.M.U. WALL
=	NEW CONCRETE WALL
=	NEW BEAM
	=